
RESIDENTIAL 5/252A LAKEMBA STREET

LAKEMBA NSW





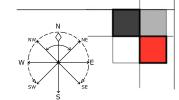

BUILDING DESIGNER
AHMED JADID
119 WILLOUGHBY RD
CROWS NEST , 2065 NSW
MOB: 0404 648 251

REVISIONS

ISSUE A - 23.10.2024 ISSUE B - 15.11.2025 ISSUE C (STAGE II) - 01.04.2025 ISSUE C (STAGE II) - 16.04.2025

P

ERS

 Ω

 \perp

 ∞

CLIENT TANIA AHMED

ADDRESS UNIT 5/252A LAKEMBA ST LAKEMBA NSW

PROJECT
CONVERT THE EXISTING CARETAKERS STORE WHICH FORMS PART OF LOT 5 TO A HOME OFFICE (ANCILLARY TO THE MAIN DWELLING)

DRAWN BY A.J

ISSUE DATE 16.04.2025

PROJECT NO.

2024.031

DESCRIPTION COVER PAGE

REVISION NO.



Z 4 601 COVER PAGE (LOCATION MAP)

WASTE MANAGEMENT PLAN

001 PROPOSED SITE FLOOR PLAN

006 PROPOSED SITE FLOOR PLAN / ROOF PLAN

008 PROPOSED SECTION \$ NORTH ELEVATIONS

004 PROPOSED DEMOLITION, EROSION, SEDIMENT CONTROL

002 GENERAL SPECIFICATIONS

003 EXISTING SITE PLAN

005 PROPOSED SITE PLAN

009 PROPOSED ELEVATIONS

GENERAL NOTES

CONSTRUCTION REQUIREMENTS ARE TO COMPLY WITH THE NATIONAL CONSTRUCTION CODE, GENERAL

- DRAWINGS PREPARED FROM INFORMATION SUPPLIED BY THE OWNER AND/OR BUILDER.
- DIMENSIONS ARE IN MILLIMETERS UNLESS NOTED OTHERWISE.
- ALL DIMENSIONS SHALL BE VERIFIED ON SITE.
- ACTUAL SURVEYED LEVELS TO TAKE PRECEDENCE.
- DO NOT SCALE OFF DRAWINGS.
- IT IS THE RESPONSIBILITY OF THE BUILDER TO VERIFY DOCUMENTS AS TO THEIR ACCURACY

 AND SUITABILITY.
- THESE PLANS ARE TO BE READ IN CONJUNCTION WITH ENGINEER'S DETAILS.
- NCC REFERS TO THE NATIONAL CONSTRUCTION CODE VOLUME 2, BUILDING CODE OF
 AUSTRALIA CLASS 1 AND CLASS 10 BUILDINGS.

STATUTORY REQUIREMENTS

- ALL WORK TO BE CARRIED OUT IN ACCORDANCE WITH THE NCC, A63959-2018, THE RF9
 BUSHFIRE GUIDELINES PLANNING FOR BUSH
- FIRE PROTECTION 2019 FOR NSW WHICH ARE TO TAKE PRECEDENCE, CONDITIONS IMPOSED BY
 THE LOCAL AUTHORITY AND THE COMMITMENTS OUTLINED IN THE RELEVANT BASIX
 GERTIFICATE
- THE BUILDER IS TO COMPLY WITH THE REQUIREMENTS OF ALL LEGALLY CONSTITUTED
 AUTHORITIES HAVING JURISDICTION OVER THE BUILDING
- . WORKS AND THE PROVISIONS OF THE HOME BUILDING ACT.
- PRIOR TO THE COMMENCEMENT OF BUILDING WORK, THE BUILDER SHALL PROVIDE
 TEMPORARY TOILET FACILITIES FOR THE USE OF SUBCONTRACTORS WHERE THE LOCAL
 AUTHORITY REQUIRES THE TEMPORARY TOILET, ON COMPLETION THE BUILDER SHALL REMOVE
 THE CONVENIENCE

NCC REQUIREMENTS

- ALL EARTHWORKS SHALL BE IN ACCORDANCE WITH THE ENGINEER'S DETAILS AND PART 3.1.1
 OF NCC.
- ALL EXCAVATIONS AND UNDER FLOOR FILL SHALL BE IN ACCORDANCE WITH THE ENGINEER'S

 DETAILS AND PART 3.1.1 OF NCC
- ALL EARTH RETAINING STRUCTURES SHALL BE IN ACCORDANCE WITH THE ENGINEER'S DETAILS AND PART 3.1.2 OF NCC
- STORM WATER DRAINAGE SHALL BE CARRIED OUT IN ACCORDANCE WITH PART 3.1.3 OF NCC.
- PRIMARY BUILDING ELEMENTS ARE TO BE PROTECTED FROM SUBTERRANEAN TERMITES IN

 ACCORDANCE WITH PAR 3.1.4 OF NCC
- ALL FOOTINGS AND SLABS SHALL COMPLY WITH PART 3.2 OF NCC.
- CLAY BRICKWORK SHALL COMPLY WITH PART 3.3 OF NCC, \$ A64113 OR A63100
- MASONRY ACCESSORIES SHALL BE CONSTRUCTED AND INSTALLED IN ACCORDANCE WITH AS4113 OR AS3100. APPROPRIATE TIES SHALL BE PROVIDED TO ARTICULATED MASONRY JOINTS.
- LINTELS USED TO SUPPORT BRICKWORK OVER WALL OPENINGS SHALL COMPLY WITH AS4113
 OR AS3100 AND BE PROTECTED FROM CORROSION.
- WEATHERPROOFING OF EXTERNAL MASONRY WALLS SHALL BE CARRIED OUT IN ACCORDANCE WITH A64113 OR A63100.
- ENGAGED PIERS IN SINGLE LEAF MASONRY WALLS SHALL BE CONSTRUCTED IN ACCORDANCE WITH AS4113 OR AS3100.

NCC REQUIREMENTS

- PROVIDE ADEQUATE CROSS VENTILATION TO SPACE UNDER SUSPENDED GROUND FLOORS
 IN ACCORDANCE WITH PART 3.4.1 OF NCC. SUB FLOOR ACCESS TO BE PROVIDED AS
 INDICATED ON THE PLAN
- ALL TIMBER FRAMEWORK SHALL COMPLY WITH PART 3.4.3 OF NCC OR ASI684.
- ROOF TRUSSES SHALL BE DESIGNED IN ACCORDANCE ASI120, AND ERECTED, FIXED AND BRACED IN ACCORDANCE WITH MANUFACTURER'S RECOMMENDATIONS.
- ROOF CLADDING, GUTTERS AND DOWNPIPES AND WALL CLADDING SHALL BE IN

 ACCORDANCE WITH PART 3.5 OF NCC
- SARKING SHALL COMPLY WITH AS/NZS4200.1\$2.
- ALL GLAZING SHALL COMPLY WITH PART 3.6 OF NCC.
- FIRE PROPERTIES FOR MATERIALS AND CONSTRUCTION, MUST COMPLY WITH PART 3.1.1 OF NGC
- FIRE SEPARATION, WHERE REQUIRED, MUST COMPLY WITH PART 3.1.2 OF NCC.
- FIRE PROTECTION OF SEPARATING WALLS AND FLOORS, MUST COMPLY WITH PART 3.7.3 OF NCC.
- FIRE SEPARATION OF GARAGE TOP DWELLINGS, MUST COMPLY WITH PART 3.1.4 OF NCC.
- PROVIDE AND INSTALL HARD WIRED INTERCONNECTED SMOKE ALARMS IN ACCORDANCE

 WITH AS3186 AND PART 3.15 OF NCC.
- INTERNAL WET AREAS AND BALCONIES OVER HABITABLE ROOMS TO BE WATERPROOFED IN ACCORDANCE WITH PART 3.8.1 OF NCC. WET
- AREA WALL LINING IS TO BE FIXED IN ACCORDANCE WITH MANUFACTURER'S RECOMMENDATIONS.
- ALL TIMBER DOORS AND DOOR SETS SHALL BE MANUFACTURED AND INSTALLED IN
 ACCORDANCE WITH AS2041.
- ALL PLUMBING SHALL COMPLY WITH THE REQUIREMENTS OF THE RELEVANT SUPPLY
 AUTHORITY AND AS3000, AND BE CARRIED OUT BY ALICENSED PLUMBER
- ALL ELECTRICAL WORK SHALL COMPLY WITH THE REQUIREMENTS OF THE RELEVANT SUPPLY AUTHORITY AND AS3000, AND BE CARRIED OUT
 BY A LICENSED FLECTRICIAN
- ALL GAS INSTALLATIONS SHALL COMPLY WITH THE REQUIREMENTS OF THE RELEVANT SUPPLY AUTHORITY AND BE CARRIED OUT BY A LICENSED
 GAS FITTER.
- INSTALLATION OF WALL AND FLOOR TILES SHALL BE IN ACCORDANCE WITH AS3958.1.
- MECHANICAL VENTILATION IS TO BE INSTALLED IN ACCORDANCE WITH PART 3.8.5 OF NCC.
- BUILDING FABRIC MUST COMPLY WITH PART 3.12.1 OF NCC.

<

- INSULATION, WHERE REQUIRED, MUST COMPLY WITH AS/NZS4859.1.
- BUILDING IS TO BE SEALED TO THE REQUIREMENTS OF PART 3.12.3 OF NCC, INCLUDING CHIMNEYS, FLUES, ROOF LIGHTS, EXTERNAL WINDOWS AND DOORS, EXHAUST FANS, ROOF, WALLS AND FLOORS.
- SERVICES ARE TO BE INSTALLED TO THE REQUIREMENTS OF NSW PART 3.12.5 OF NCC, INCLUDING HOT WATER SUPPLY, INSULATION OF SERVICES, CENTRAL HEATING WATER PIPING AND HEATING AND COOLING DUCT WORK.

BUILDING DESIGNER
AHMED JADID
II 9 WILLOUGHBY RD
CROWS NEST , 2065 NSW
MOB: 0404 648 25I

CD

REVISIONS

| ISSUE A - 23.10.2024 | ISSUE B - 15.11.2025 | ISSUE C (STAGE II) - 01.04.2025 | ISSUE C (STAGE II) - 16.04.2025

CLIENT TANIA AHMED

ADDRESS UNIT 5/252A LAKEMBA ST LAKEMBA NSW _

5

ш

 Ω

T

00

PROJECT CONVERT THE EXISTING CARETAKERS STORE WHICH FORMS PART OF LOT 5 TO A HOME OFFICE (ANCILLARY TO THE MAIN DUIST LING)

DRAWN BY

c

ব


16.04.2025

PROJECT NO. 2024.031

DESCRIPTION
GENERAL SPECIFICATIONS



ALICE STREET

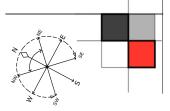

BUILDING DESIGNER
AHMED JADID
119 WILLOUGHBY RD
CROWS NEST, 2065 NSW
MOB: 0404 648 251

REVISIONS

ISSUE A - 23.10.2024 ISSUE B - 15.11.2025 199UE C (9TAGE II) - 01.04.2025 199UE C (9TAGE II) - 16.04.2025

CLIENT TANIA AHMED

ADDRESS UNIT 5/252A LAKEMBA ST LAKEMBA NSW

GNERS

BUILDIN

 $\circ \emptyset$

PROJECT
CONVERT THE EXISTING
CARETAKERS STORE
WHICH FORMS PART OF
LOT 5 TO A HOME OFFICE (ANCILLARY TO THE MAIN DWELLING)

DRAWN BY A.J


16.04.2025


PROJECT NO. 2024.031


DESCRIPTION

EXISTING SITE PLAN



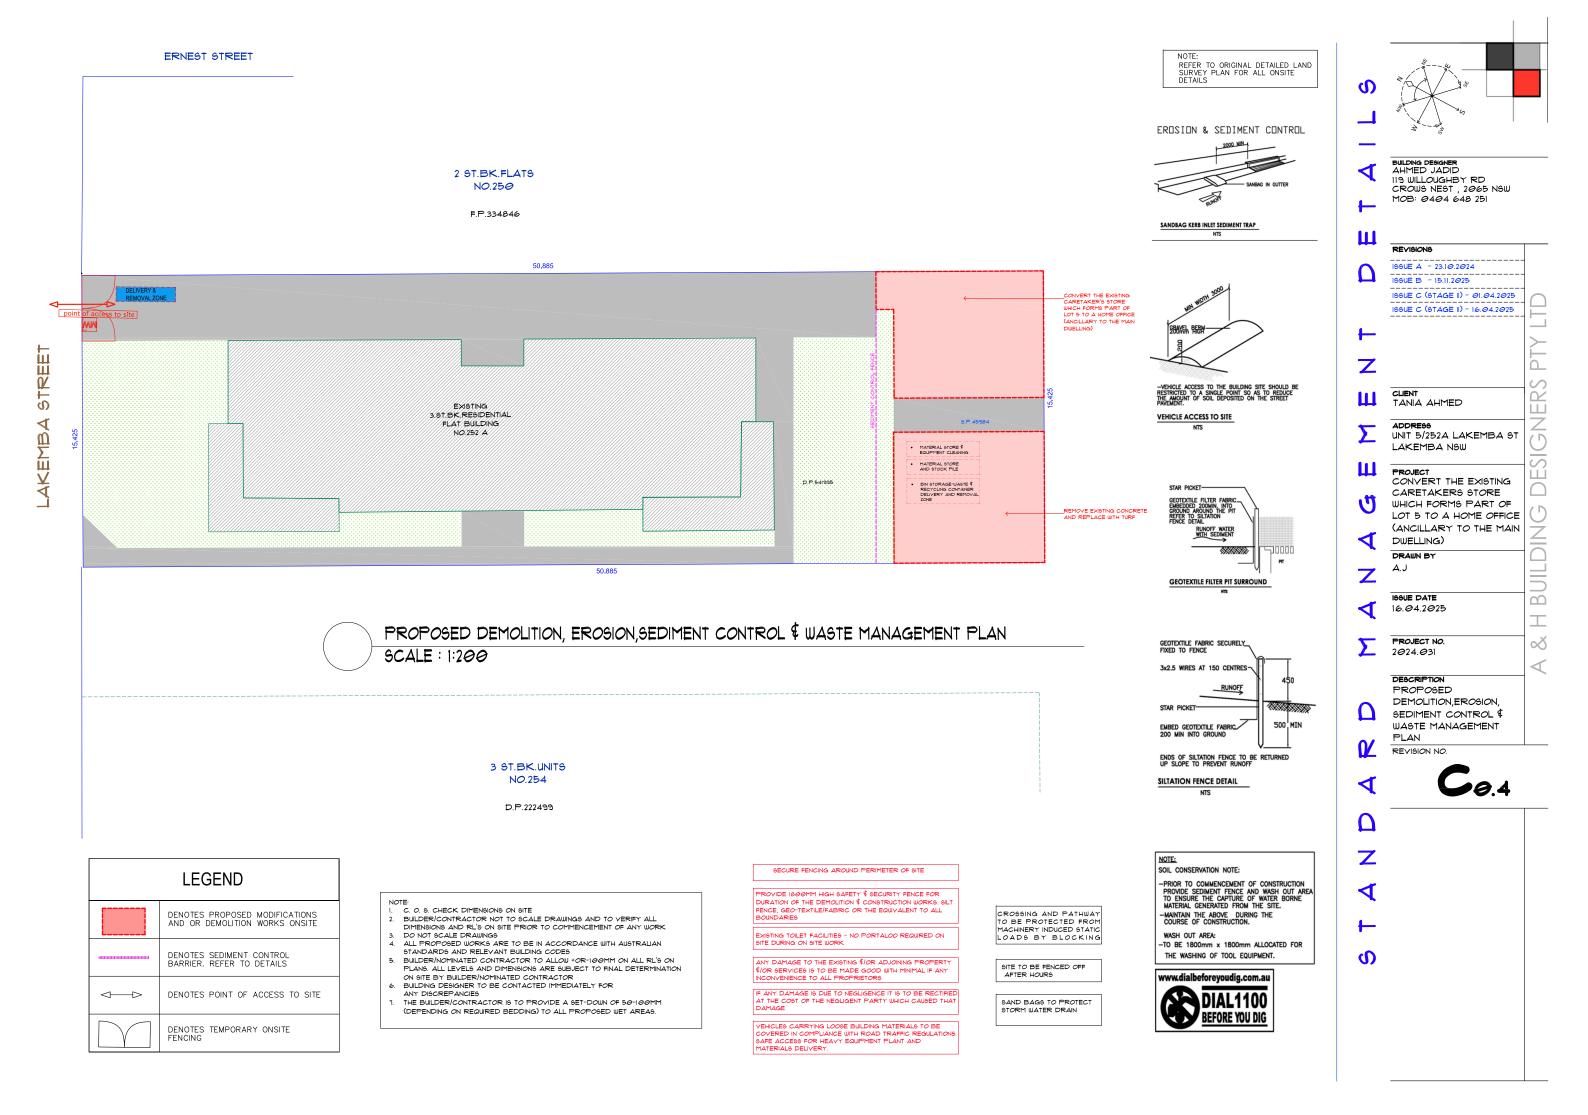

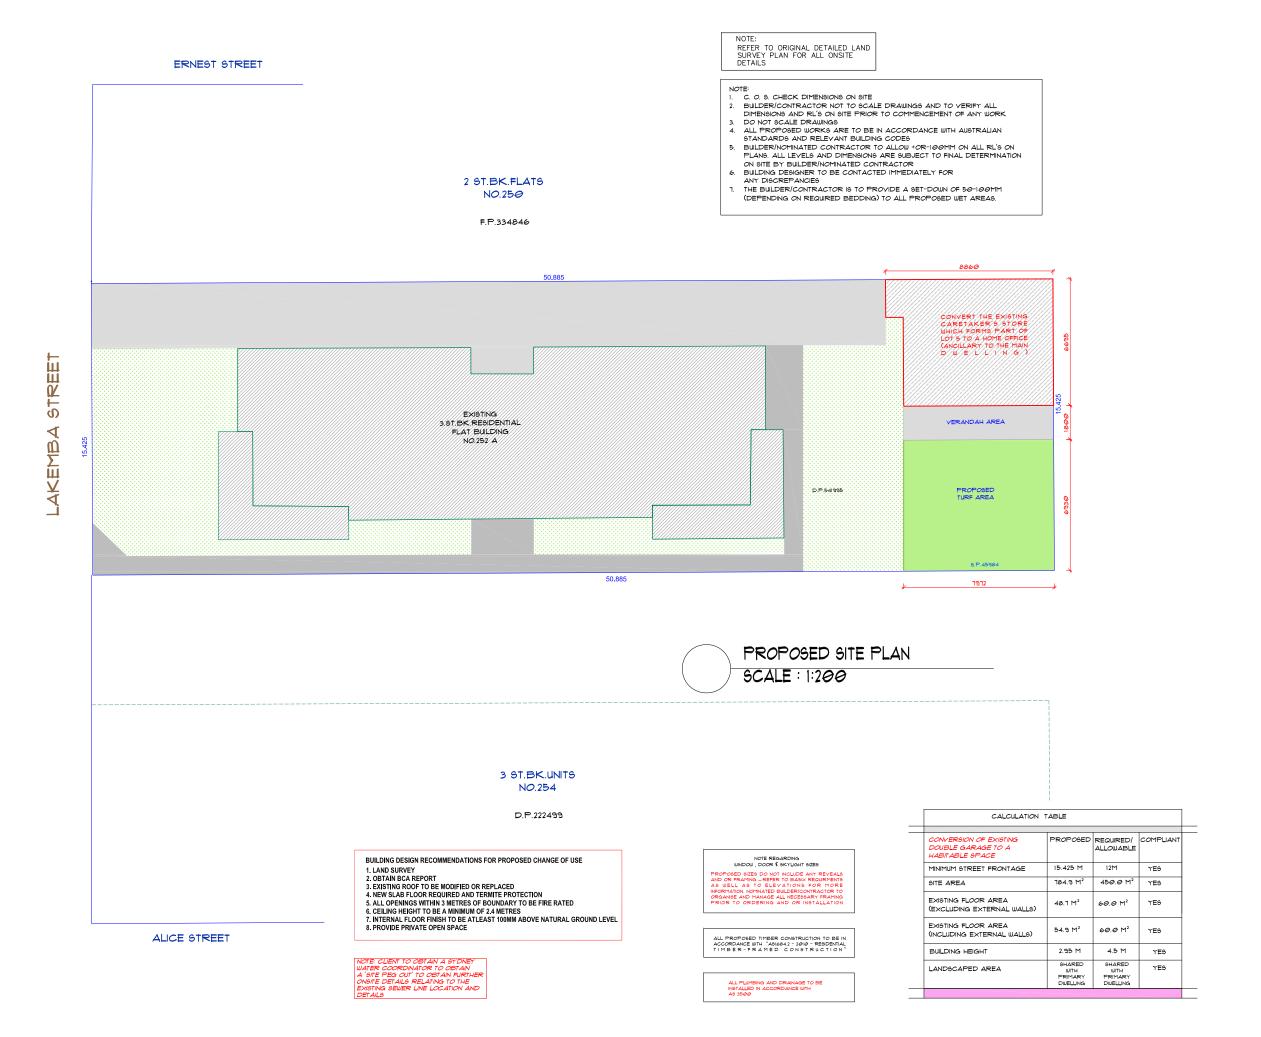

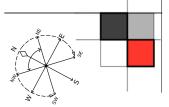

BUILDING DESIGNER
AHMED JADID
119 WILLOUGHBY RD
CROWS NEST, 2065 NSW
MOB: 0404 648 251

REVISIONS

| ISSUE A - 23.10.2024 | ISSUE B - I5.II.2025 | ISSUE C (STAGE II) - 01.04.2025

199UE C (9TAGE II) - 16.04.2025

CLIENT TANIA AHMED

ADDRESS UNIT 5/252A LAKEMBA ST LAKEMBA NSW ERS

 \bigcirc

00

PROJECT
CONVERT THE EXISTING
CARETAKERS STORE
WHICH FORMS PART OF
LOT 5 TO A HOME OFFICE
(ANCILLARY TO THE MAIN
DWELLING)

DRAWN BY

ISSUE DATE 16.04.2025

PROJECT NO. 2024.031

DESCRIPTION
PROPOSED SITE PLAN



NOTE CLENT TO OBTAIN A SYDNEY WATER COORDINATOR TO OBTAIN A "SITE PEG OUT TO OBTAIN FURTHER ONSITE DETAILS RELATING TO THE ENSTING SEVER LINE LOCATION AND DETAILS 2 ST.BK.FLATS NO.250 F.P.334846 50 885 PROPOSED 216MM DOUBLE BRICK
WALLS TO UNDERSIDE OF ROOF SHEETING
TO HAVE AN FRI. OF 69/69/69 TO
COMPLY WITH BCAINCO REGUIREMENTS
PROPOSED MECHANICAL
VENTILATION TO PROPOSED WET
AREA TO COMPLY WITH BCAINCC BUILDING DESIGNER
AHMED JADID
119 WILLOUGHBY RD
CROWS NEST , 2065 NSW
MOB: 0404 648 251 NEW CONCRETE SLAB TO ENGINEER'S DETAIL \$ SPECIFICATIONS PROPOSED FIRE RATED SKYLIGHTS TO BE SELECTED AND COMPLY WITH BCA/NCC STREET EXISTING 3.5T.BK.RESIDENTIAL FLAT BUILDING NO.252 A REVISIONS ISSUE A - 23.10.2024 ISSUE B - 15.11.2025 D.P.541995 EXISTING II OMM BRICK WALL 199UE C (9TAGE 11) - 01.04.2025 LAKEMBA 199UE C (9TAGE II) - 16.04.2025 ERS CLIENT TANIA AHMED ADDRESS UNIT 5/252A LAKEMBA ST LAKEMBA NSW PROJECT
CONVERT THE EXISTING
CARETAKERS STORE
WHICH FORMS PART OF PROPOSED SITE / FLOOR PLAN SCALE: 1:200 LOT 5 TO A HOME OFFICE (ANCILLARY TO THE MAIN DWELLING) DRAWN BY A.J2 ST.BK.FLATS NO.250 ISSUE DATE \bigcirc 16.04.2025 F.P.334846 PROJECT NO. $\circ \lozenge$ 2024.031 50.885 -PROPOSED 210MM DOUBLE BRICK
WALLS TO UNDERSIDE OF ROOF SHEETING
TO HAVE AN FRL OF 60/60/60 TO
COMPLY WITH BCA/NCC REQUIREMENTS PROPOSED SITE/ FLOOR PLAN ROOF PLAN REVISION NO. PROPOSED FIRE RATED
SKYLIGHTS TO BE SELECTED AND
COMPLY WITH BCA/NCC **C**0.6 STREET EXISTING 3.ST.BK.RESIDENTIAL FLAT BUILDING D.P.541995 4 LAKEMB BUILDING DESIGN RECOMMENDATIONS FOR PROPOSED CHANGE OF USE BUILDING DESIGN RECOMMENDATIONS FOR PROPOSED CHANGE OF USE

1. LAND SURVEY

2. OBTAIN BCA REPORT

3. EXISTING ROOF TO BE MODIFIED OR REPLACED


4. NEW SLAB FLOOR REQUIRED AND TERMITE PROTECTION

5. ALL OPENINGS WITHIN 3 METRES OF BOUNDARY TO BE FIRE RATED


6. CEILING HEIGHT TO BE A MINIMUM OF 2.4 METRES

7. INTERNAL FLOOR FINISH TO BE ATLEAST 100MM ABOVE NATURAL GROUND LEVEL

8. PROVIDE PRIVATE OPEN SPACE PROPOSED SITE / ROOF PLAN SCALE: 1:200

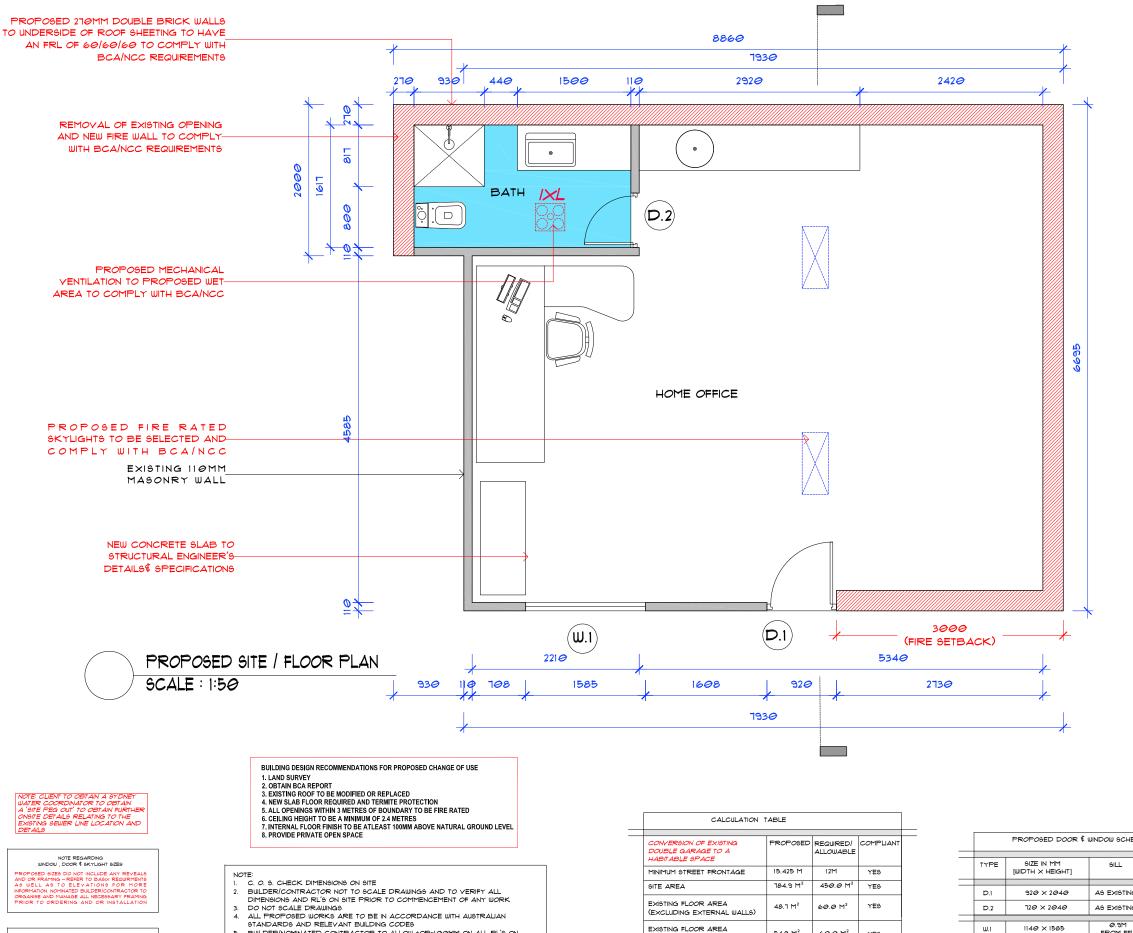

LANDSCAPED AREA

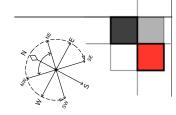

BUILDING DESIGNER AHMED JADID 119 WILLOUGHBY RD CROWS NEST , 2065 NSW MOB: 0404 648 251

REVISIONS

ISSUE A - 23.10.2024 ISSUE B - 15.11.2025 199UE C (9TAGE 11) - 01.04.2025 199UE C (9TAGE II) - 16.04.2025

CLIENT TANIA AHMED

ADDRESS

UNIT 5/252A LAKEMBA ST LAKEMBA NSW

ERS

 \bigcirc

 $\circ \lozenge$

PROJECT
CONVERT THE EXISTING CARETAKERS STORE WHICH FORMS PART OF LOT 5 TO A HOME OFFICE (ANCILLARY TO THE MAIN DWELLING)

DRAWN BY A.J

> ISSUE DATE 16.04.2025

PROJECT NO.

2024.031

DESCRIPTION PROPOSED SITE! FLOOR PLAN

REVISION NO.




ALL PROPOSED TIMBER CONSTRUCTION TO BE IN ACCORDANCE WITH "ASIGNA2 - 2010 - RESIDENTIAL TIMBER - FRAMED CONSTRUCTION"

NO.	TE:
1.	C. O. S. CHECK DIMENSIONS ON SITE
2.	BUILDER/CONTRACTOR NOT TO SCALE DRAWINGS AND TO VERIFY ALL
	DIMENSIONS AND RL'S ON SITE PRIOR TO COMMENCEMENT OF ANY WORK
3.	DO NOT SCALE DRAWINGS
4.	ALL PROPOSED WORKS ARE TO BE IN ACCORDANCE WITH AUSTRALIAN
	STANDARDS AND RELEVANT BUILDING CODES
5.	BUILDER/NOMINATED CONTRACTOR TO ALLOW +OR-100MM ON ALL RL'S ON
	PLANS. ALL LEVELS AND DIMENSIONS ARE SUBJECT TO FINAL DETERMINATION
	ON SITE BY BUILDER/NOMINATED CONTRACTOR
6.	BUILDING DESIGNER TO BE CONTACTED IMMEDIATELY FOR
	ANY DISCREPANCIES
٦.	THE BUILDER/CONTRACTOR IS TO PROVIDE A SET-DOWN OF 50-100MM
	(DEPENDING ON REQUIRED BEDDING) TO ALL PROPOSED WET AREAS.

CONVERSION OF EXISTING DOUBLE GARAGE TO A	PROPOSED	REQUIRED/ ALLOWABLE	COMPLIANT
IABITABLE SPACE			
MUM STREET FRONTAGE	15.425 M	12M	YES
TE AREA	184.9 M ²	450.0 M²	YES
XISTING FLOOR AREA			
EXCLUDING EXTERNAL WALLS)	48.1 M²	60.0 M²	YES
EXISTING FLOOR AREA INCLUDING EXTERNAL WALLS)	54.9 M ²	60.0 M²	YES
BUILDING HEIGHT	2.95 M	4.5 M	YES

YES

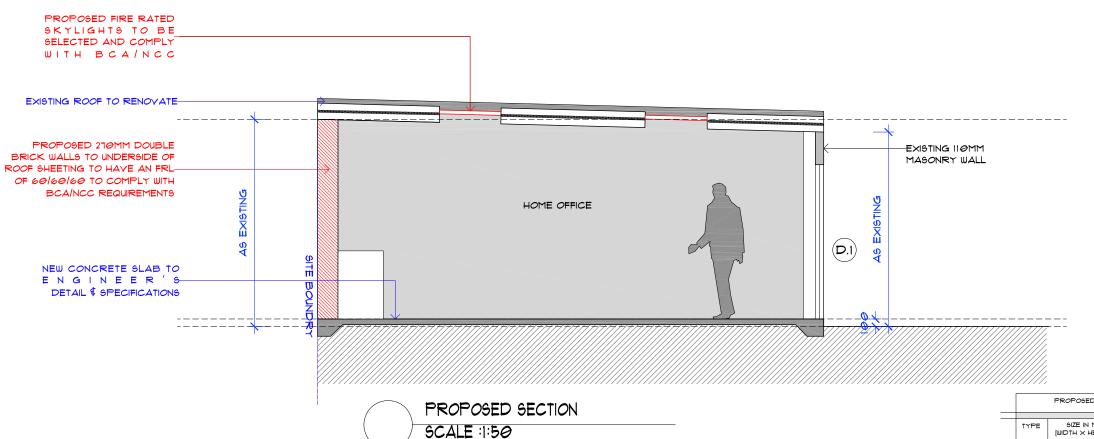

PROPOSED NORTH ELEVATION

SCALE :1:50

EXISTING

Αg

SIZE IN MM [WIDTH × HEIGHT] SILL D.I 920 × 2040 AS EXISTING AS EXISTING D.2 720 × 2040 AS EXISTING AS EXISTING

BUILDING DESIGN RECOMMENDATIONS FOR PROPOSED CHANGE OF USE

CALCULATION TABLE				
CONVERSION OF EXISTING DOUBLE GARAGE TO A HABITABLE SPACE	PROPOSED	REQUIRED/ ALLOWABLE	COMPLIAN	
MINIMUM STREET FRONTAGE	15.425 M	12M	YES	
SITE AREA	184.9 M²	45 <i>0.0</i> M²	YES	
EXISTING FLOOR AREA (EXCLUDING EXTERNAL WALLS)	48.1 M²	60.0 M²	YES	
EXISTING FLOOR AREA (INCLUDING EXTERNAL WALLS)	54.9 M²	60.0 M²	YE9	
BUILDING HEIGHT	2.95 M	4.5 M	YES	
LANDSCAPED AREA	SHARED WITH PRIMARY DWELLING	SHARED WITH PRIMARY DWELLING	YE9	

- 1. C. O. 9. CHECK DIMENSIONS ON SITE
 2. BUILDER/CONTRACTOR NOT TO SCALE DRAWINGS AND TO VERIFY ALL DIMENSIONS AND RU'S ON SITE PRIOR TO COMMENCEMENT OF ANY WORK
 3. DO NOT SCALE DRAWINGS
 4. ALL PROPOSED WORKS ARE TO BE IN ACCORDANCE WITH AUSTRALIAN STANDARDS AND RELEVANT BUILDING CODES
 5. BUILDER/NOMINATED CONTRACTOR TO ALLOW +OR-I-00MM ON ALL RL'S ON PLANS, ALL LEVES AND DIMENSIONS ARE SUBJECT TO FINAL DETERMINATION ON SITE BY BUILDER/NOMINATED CONTRACTOR
 6. BUILDING DESIGNER TO BE CONTACTED IMMEDIATELY FOR ANY DISCREP-ANCIES

NOTE REGARDING WINDOW, DOOR \$ 9KYLIGHT 9IZE9:

DBED BIZES DO NOT INCLUDE ANY REVEALS R FRAMING - REFER TO BASIX REQUIRMENTS ELL AS TO ELEVATIONS FOR MORE

ALL PROPOSED TIMBER CONSTRUCTION TO BE IN ACCORDANCE WITH "ASI6842 - 2010 - RESIDENTIAL TIMBER - FRAMED CONSTRUCTION"

PROPOSED DOOR \$ WINDOW SCHEDULE

BUILDING DESIGN RECOMMENDATIONS FOR PROPOSED CHANGE OF USE

1. LAND SURVEY
2. OBTAIN BCA REPORT
3. EXISTING ROOF TO BE MODIFIED OR REPLACED
4. NEW SLAB FLOOR REQUIRED AND TERMITE PROTECTION
5. ALL OPENINGS WITHIN 3 METRES OF BOUNDARY TO BE FIRE RATED
6. CELING HEIGHT TO BE A MINIMUM OF 2.4 METRES
7. INTERNAL FLOOR FINISH TO BE ATLEAST 100MM ABOVE NATURAL GROUND LEVEL
8. PROVIDE PRIVATE OPEN SPACE

NOTE:
1. C. O. S. CHECK DIMENSIONS ON SITE

ANY DISCREPANCES

THE BUILDER/CONTRACTOR IS TO PROVIDE A SET-DOWN OF 50-100MM
(DEPENDING ON REQUIRED BEDDING) TO ALL PROPOSED WET AREAS.

BUILDING DESIGNER AHMED JADID 119 WILLOUGHBY RD CROWS NEST , 2065 NSW MOB: 0404 648 251

REVISIONS

ISSUE A - 23.10.2024 ISSUE B - 15.11.2025

199UE C (9TAGE 11) - 01.04.2025 199UE C (STAGE II) - 16.04.2025

CLIENT TANIA AHMED

ADDRESS

UNIT 5/252A LAKEMBA ST LAKEMBA NSW

Ш

 \bigcirc

00

PROJECT CONVERT THE EXISTING

CARETAKERS STORE WHICH FORMS PART OF LOT 5 TO A HOME OFFICE (ANCILLARY TO THE MAIN DWELLING)

DRAWN BY A.J

ISSUE DATE 16.04.2025


PROJECT NO. 2024.031

SECTION \$

DESCRIPTION PROPOSED SITE!

NORTH ELEVATION



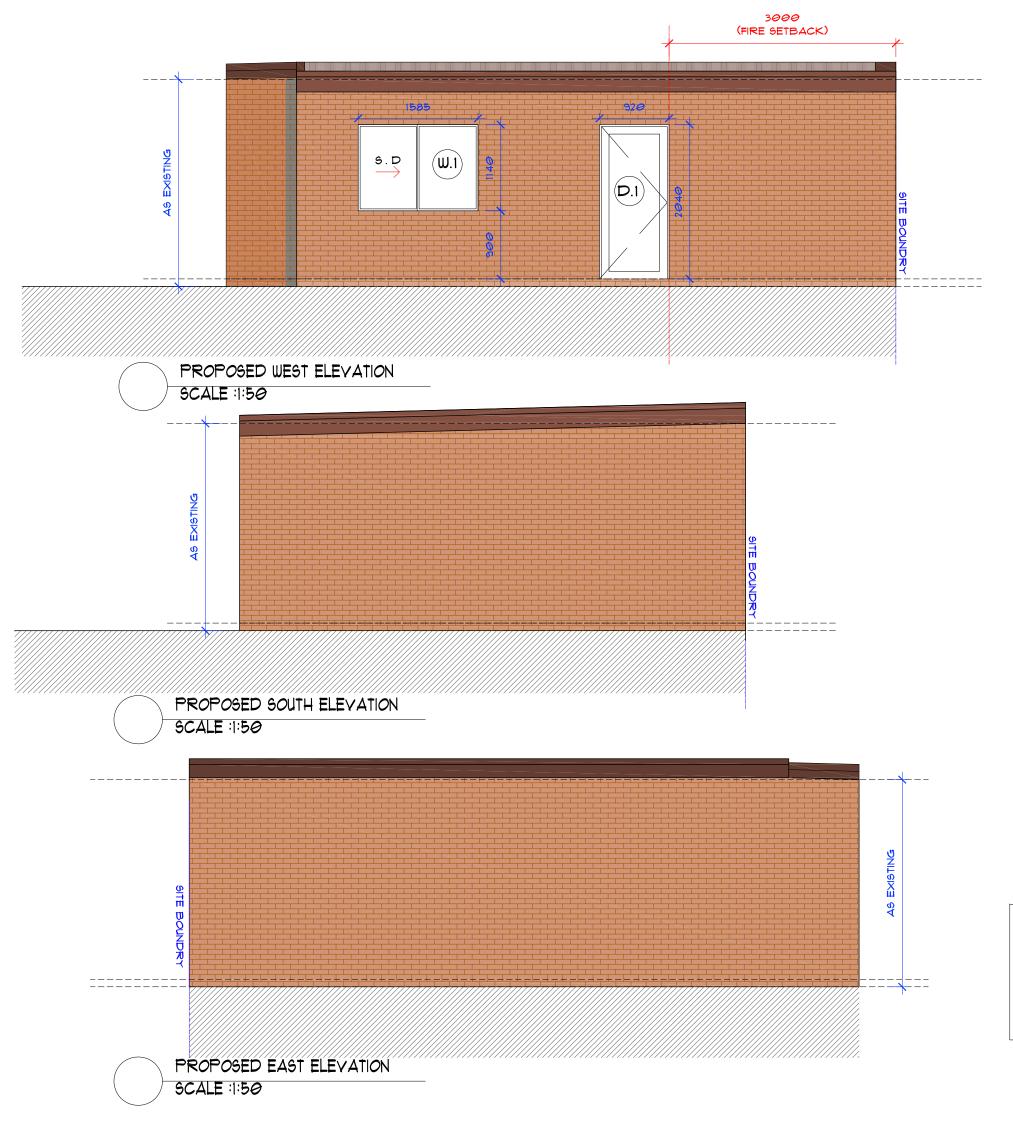

NOTE REGARDING WINDOW, DOOR \$ SKYLIGHT SIZES:

PROPOSED DOOR \$ WINDOW SCHEDULE						
TYPE	SIZE IN MM [WIDTH × HEIGHT]	SILL	9 <i>O</i> FFIT			
D.1	920 × 2040	AS EXISTING	AS EXISTING			
D.2	120 × 2040	AS EXISTING	AS EXISTING			
W.1	1140 × 1585	Ø.9M FROM FFL	2.04M FROM FFL			

BUILDING DESIGN RECOMMENDATIONS FOR PROPOSED CHANGE OF USE

- BUILDING DESIGN RECOMMENDATIONS FOR PROPOSED CHANGE OF USE

 1. LAND SURVEY
 2. OBTAIN BCA REPORT
 3. EXISTING ROOF TO BE MODIFIED OR REPLACED
 4. NEW SLAB FLOOR REQUIRED AND TERMITE PROTECTION
 5. ALL OPENINGS WITHIN 3 METRES OF BOUNDARY TO BE FIRE RATED
 6. CELLING HEIGHT TO BE A MINIMUM OF 2.4 METRES
 7. INTERNAL FLOOR FINISH TO BE ATLEAST 100MM ABOVE NATURAL GROUND LEVEL
 8. PROVIDE PRIVATE OPEN SPACE

CALCULATION TABLE					
CONVERSION OF EXISTING DOUBLE GARAGE TO A HABITABLE SPACE	PROPOSED	REQUIRED/ ALLOWABLE	COMPLIANT		
MINIMUM STREET FRONTAGE	15.425 M	12M	YES		
SITE AREA	184.9 M²	45 <i>0.0</i> M ²	YES		
EXISTING FLOOR AREA (EXCLUDING EXTERNAL WALLS)	48.1 M²	60.0 M²	YES		
EXISTING FLOOR AREA (INCLUDING EXTERNAL WALLS)	54.9 M²	60.0 M²	YE9		
BUILDING HEIGHT	2.95 M	4.5 M	YES		
LANDSCAPED AREA	SHARED WITH PRIMARY DWELLING	SHARED WITH PRIMARY DWELLING	YES		

- NOTE:

 1. C. O. 9. CHECK DIMENSIONS ON SITE

 2. BUILDER/ICONTRACTOR NOT TO SCALE DRAWINGS AND TO VERIFY ALL DIMENSIONS AND RL'S ON SITE PRIOR TO COMMENCEMENT OF ANY WORK

 3. DO NOT SCALE DRAWINGS

 4. ALL PROPOSED WORKS ARE TO BE IN ACCORDANCE WITH AUSTRALIAN STANDARDS AND RELEVANT BUILDING CODES

 5. BUILDER/INOMINATED CONTRACTOR TO ALLOW +OR-IGOMM ON ALL RL'S ON PLANS, ALL LEVELS AND DIMENSIONS ARE SUBJECT TO FINAL DETERMINATION ON SITE BY BUILDER/INOMINATED CONTRACTOR

 6. BUILDING DESIGNER TO BE CONTACTED IMMEDIATELY FOR ANY DISCREPANCIES
- ANY DISCREPANCIES
- ANT DISCREMANCIES
 THE BUILDER/CONTRACTOR IS TO PROVIDE A SET-DOWN OF 50-100MM
 (DEPENDING ON REQUIRED BEDDING) TO ALL PROPOSED WET AREAS.

BUILDING DESIGNER AHMED JADID 119 WILLOUGHBY RD CROWS NEST , 2065 NSW MOB: 0404 648 251

REVISIONS

ISSUE A - 23.10.2024 ISSUE B - 15.11.2025

199UE C (9TAGE 11) - 01.04.2025 199UE C (9TAGE II) - 16.04.2025

CLIENT TANIA AHMED

ADDRESS UNIT 5/252A LAKEMBA ST

LAKEMBA NSW

ERS

 \bigcirc

 $\circ \lozenge$

PROJECT
CONVERT THE EXISTING
CARETAKERS STORE
WHICH FORMS PART OF LOT 5 TO A HOME OFFICE (ANCILLARY TO THE MAIN DWELLING)

DRAWN BY A.J

ISSUE DATE 16.04.2025

PROJECT NO.

2024.031

DESCRIPTION

PROPOSED SITE! ELEVATIONS

